www.evgre.com



Thursday, March 24, 2016

City of Mesa Attn: Lesly David Planning Department 55 N. Center St. Mesa, AZ 85201

**Re: Proposed Development** 

**Planning & Zoning Board - Project Narrative** 

Dear Lesly:

It is our pleasure to submit to you the materials for our proposed development at 1411 South Power Road. Our team has been hard at work designing a building that blends the City of Mesa Planning Design Standards and suggestions with tenant needs and site challenges. This has resulted in what we believe to be a realistic and achievable site and building design that will bring new and exciting retail/restaurant concepts to this trade area.

#### **Project Description**

The property is a 58,765 square foot parcel located on the southeast corner of Hampton Road & Power Road. It is currently zoned Limited Commercial (LC) and our future uses will conform to existing zoning. The building is currently vacant. This former CoCo's Bakery Restaurant operated for many years, but sadly closed in late 2014. Our development request is to extend the existing building south adding  $\pm 2,700$  square foot expansion. This expansion would allow re-tenanting of the building for the proposed retail/restaurant users. The final building foot print will be  $\pm 9,200$  square feet with  $\pm 1,256$  square feet of exterior patios.

#### **Architecture & Site Enhancements**

Phone: 602-808-8600 Fax: 602-808-9100

The design of the proposed building utilizes the existing materials currently found on the CoCo's building, but also updates the colors and visual appeal of property. There are numerous additional architectural details including additional tower elements to identify entry points. The vertical elements will add character to the roof lines while the varying materials will create interest at the pedestrian level. We are proposing outdoor seating areas for each of the future fast casual restaurants with decorative railing. We are also proposing updates and enhancements to the landscaping which will bring the property in line with the City of Mesa requirements. Finally, we will improve pedestrian access to public right of way.


#### **Summary**


This proposed project re-develops an outdated restaurant and enhances the property and the surrounding developments by refreshing the building's colors and architecture. The proposed users are compliant with the existing property zoning and the surrounding shopping center users. We feel strongly that this is a wonderful project for the City of Mesa and its community. We hope you agree!

Sincerely,


Steve Russell, CCIM Evergreen Devco, Inc.




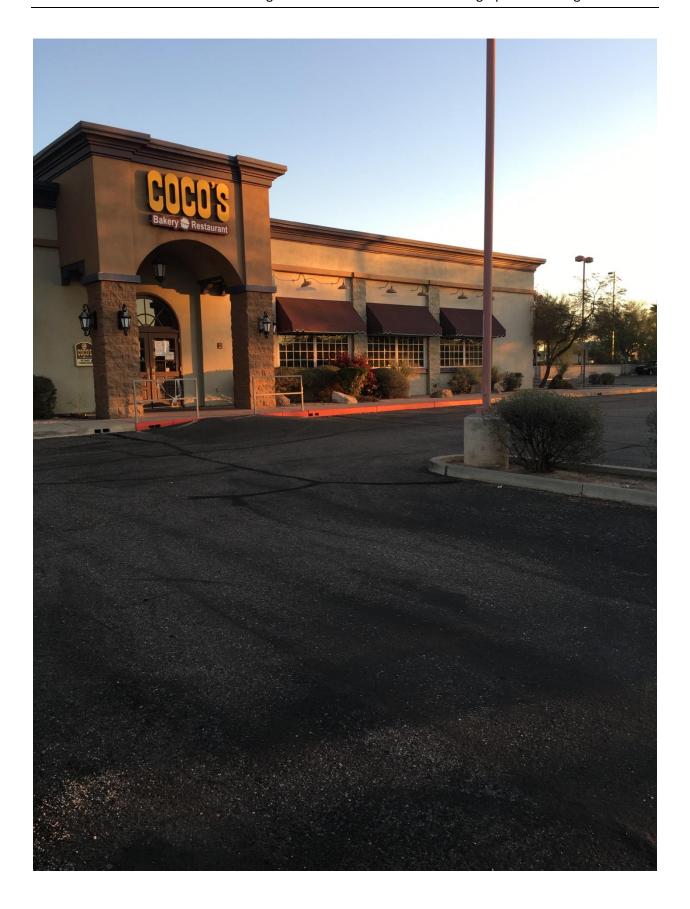

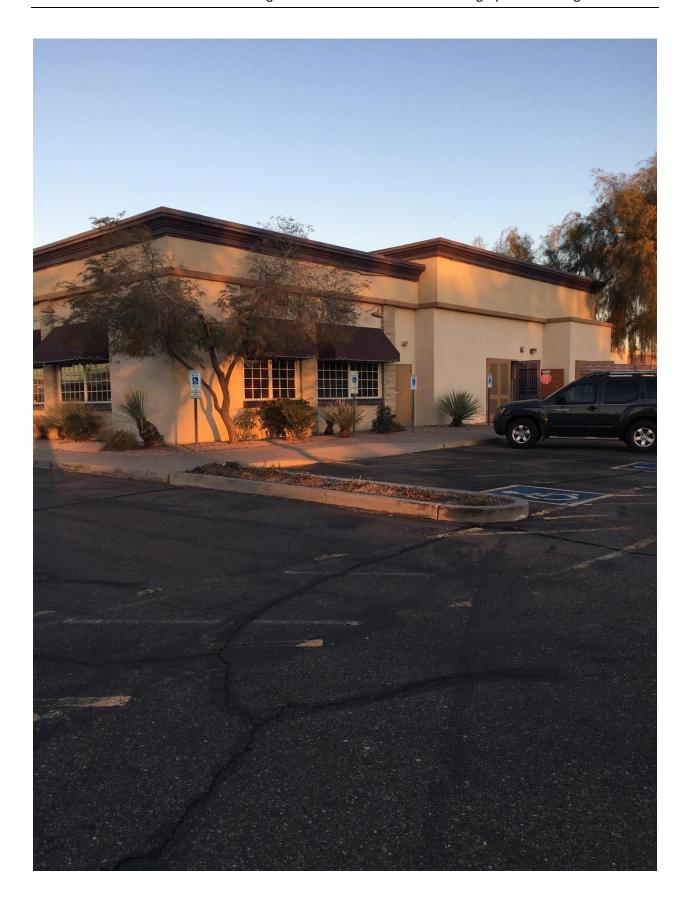



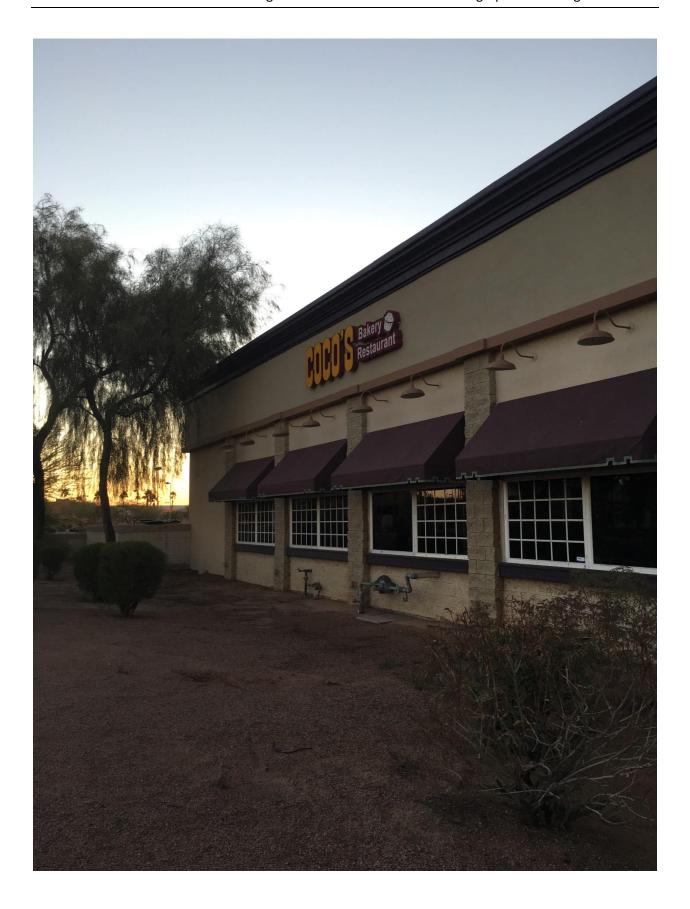

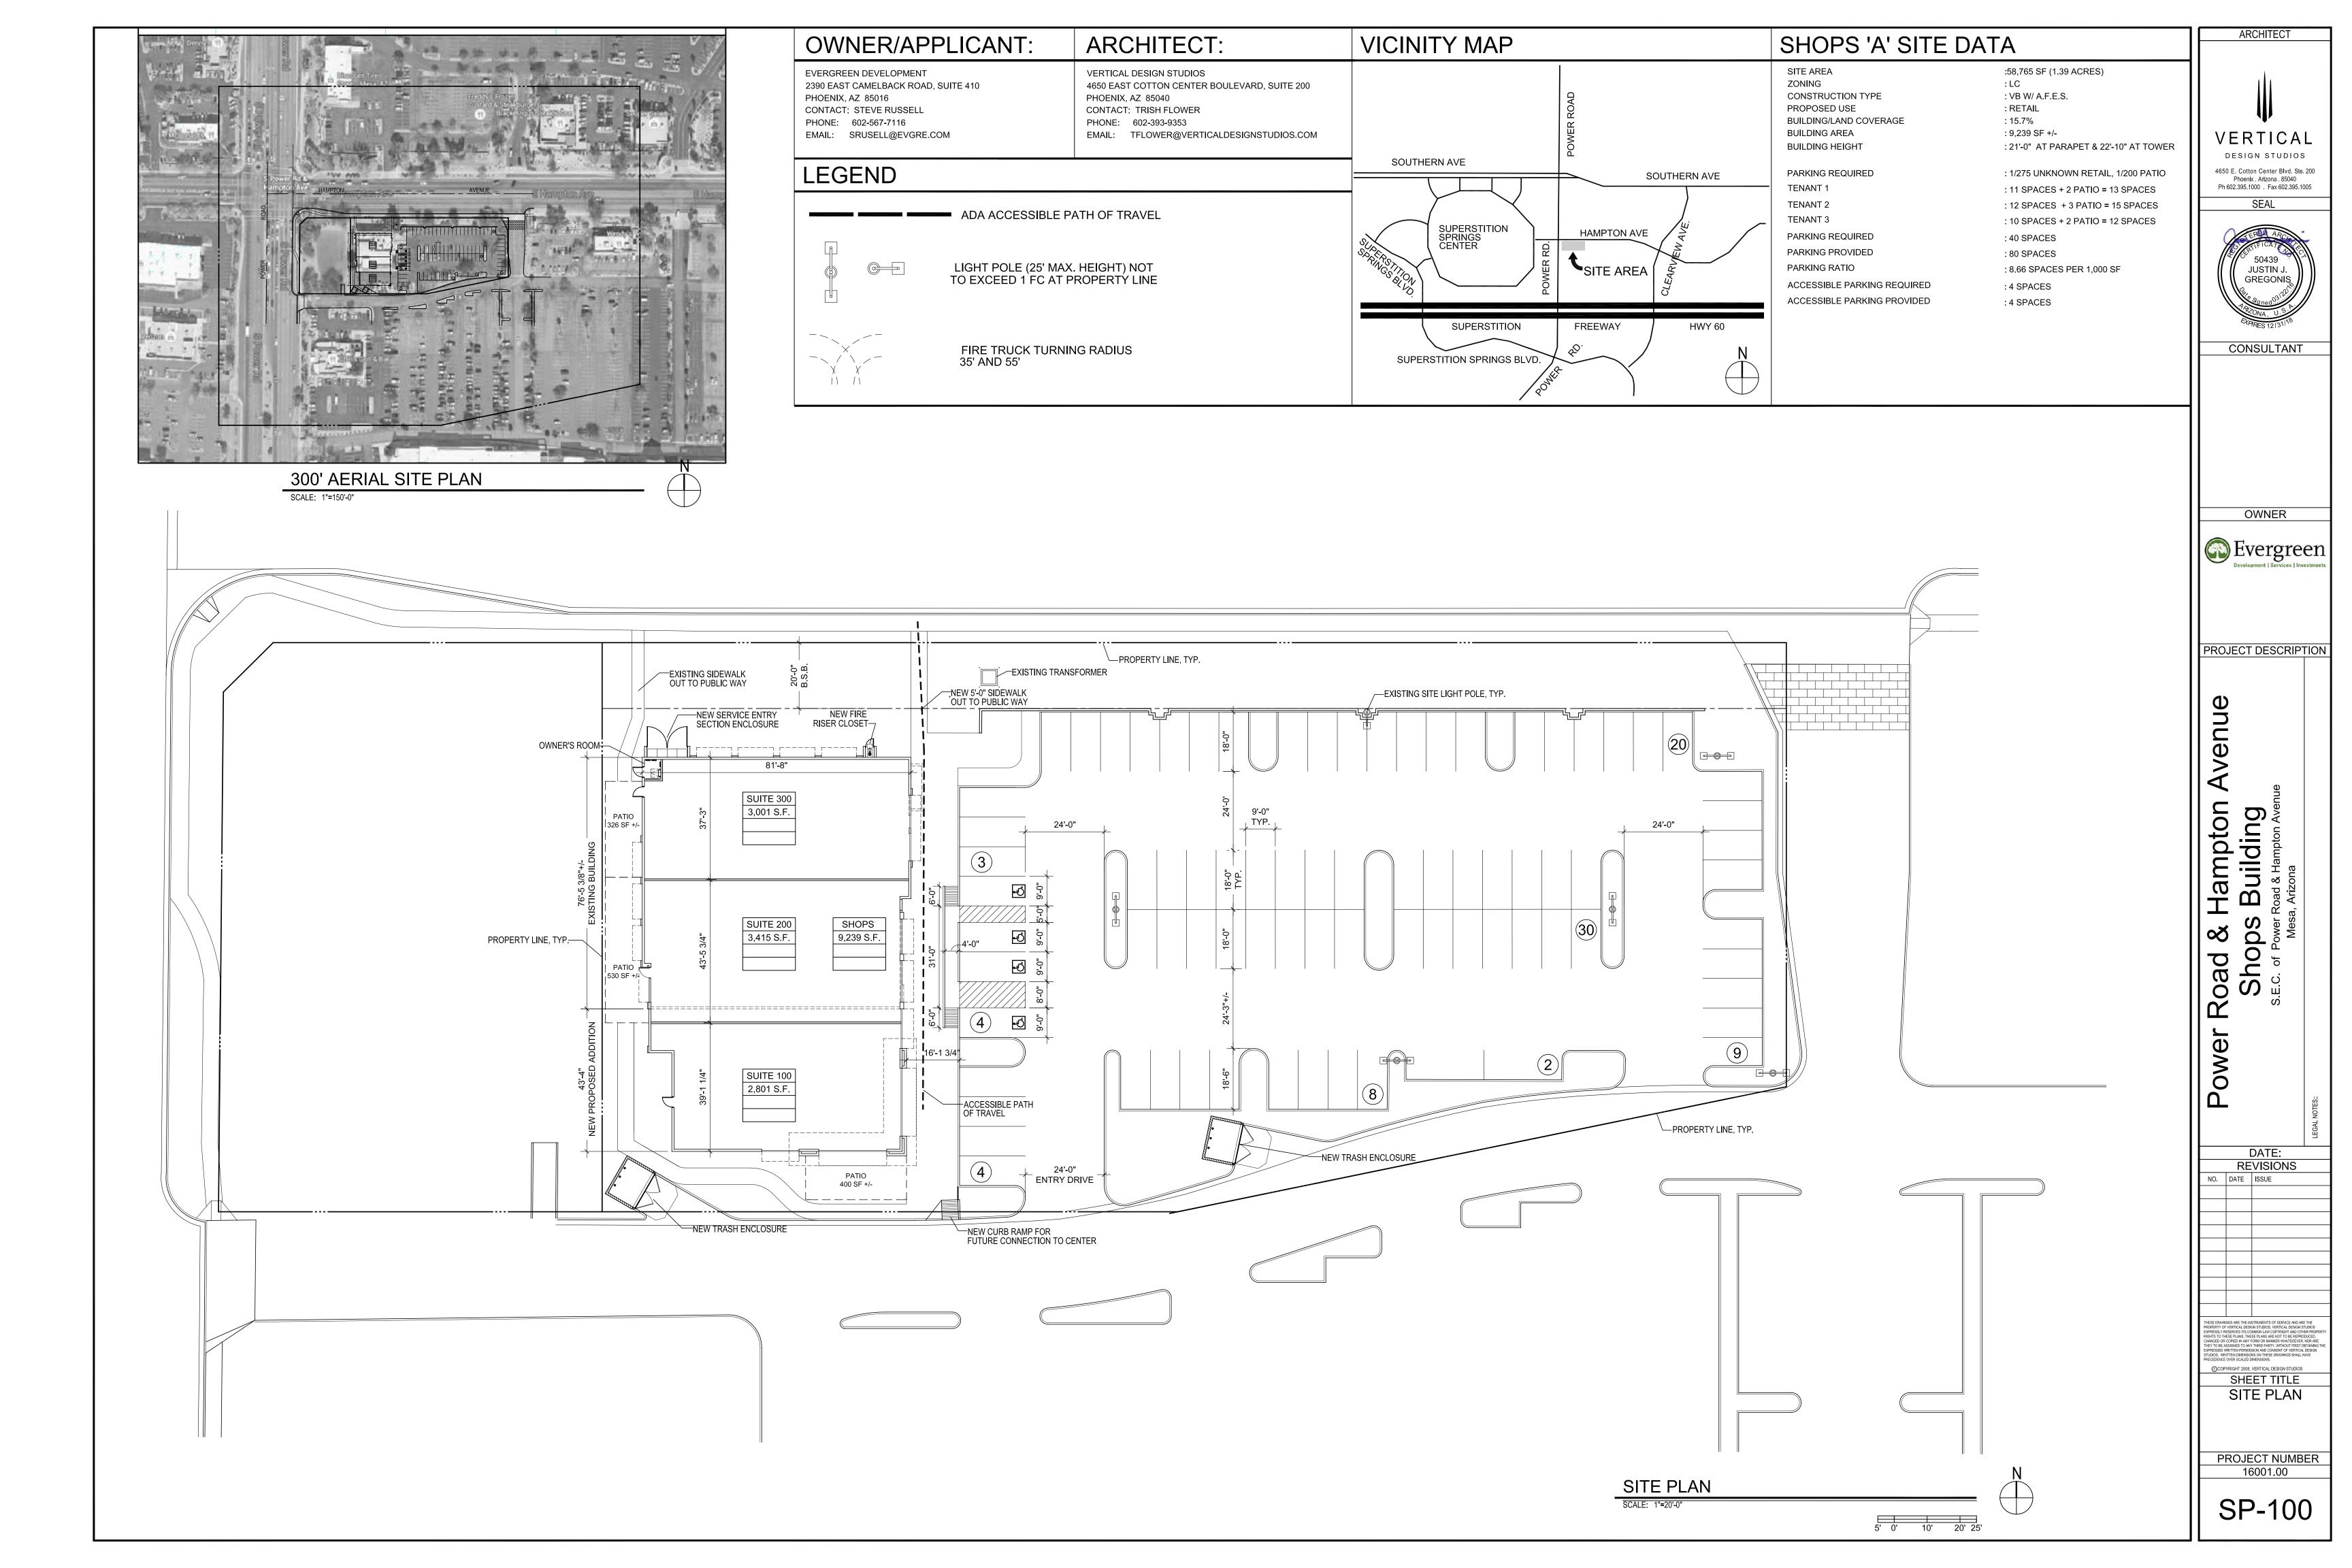


# PRELIMINARY GRADING & DRAINAGE AND EXISTING UTILITY PLANS

# SHOPS AT POWER AND HAMPTON


SEC OF POWER ROAD AND HAMPTON AVENUE

# MESA, ARIZONA

LOCATED IN THE NORTHWEST QUARTER OF SECTION 31, TOWNSHIP 1 NORTH, RANGE 7 EAST OF THE GILA AND SALT RIVER BASE AND MERIDIAN,

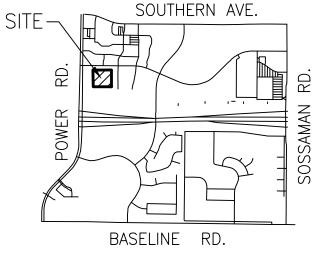

VICINITY MAP SEC 31, T. 1 N, R. 7 E

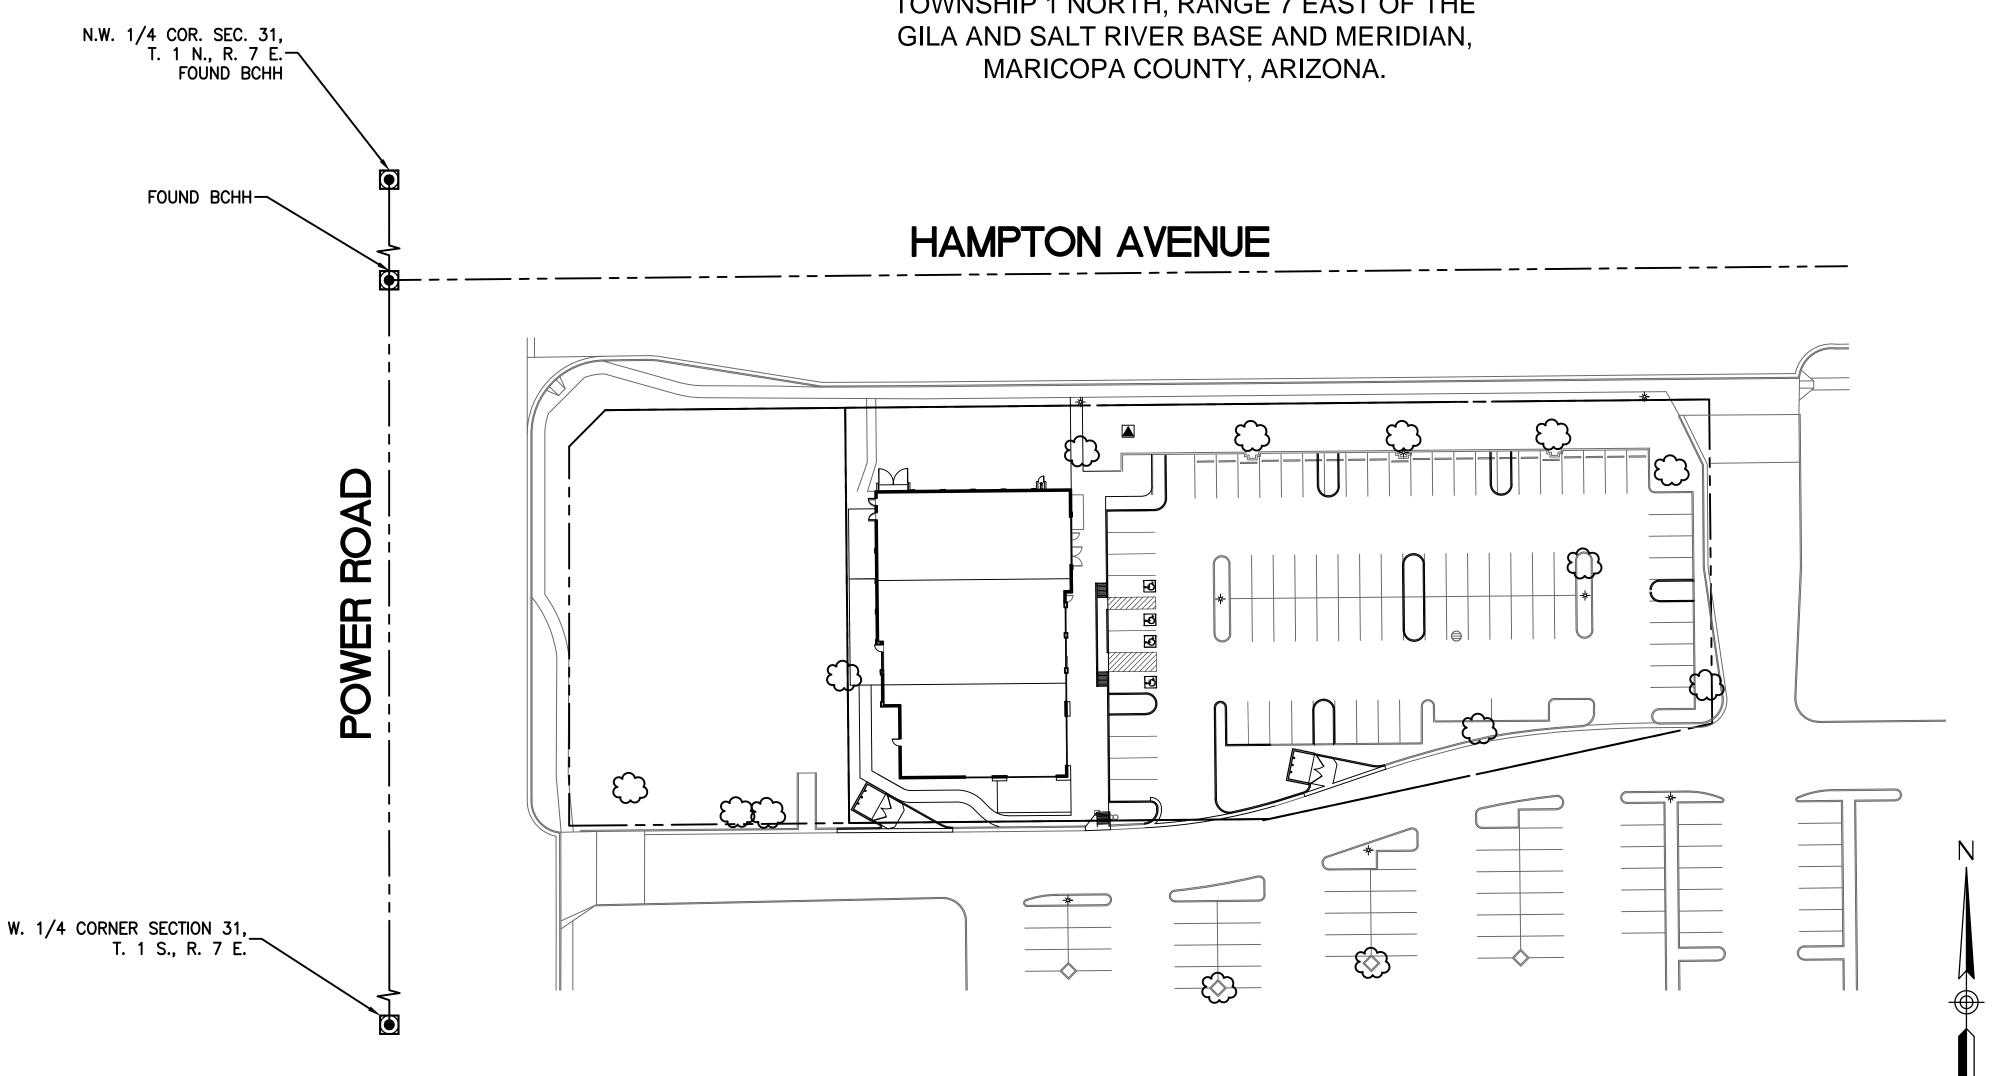

# FLOOD ZONE/FEMA CLASSIFICATION

THE SUBJECT PROPERTY LIES ENTIRELY IN ZONE X-SHADED (AREAS OF 0.2% ANNUAL CHANCE FLOOD; AREAS OF 1% ANNUAL CHANCE FLOOD WITH AVERAGE DEPTHS OF LESS THAN 1 FOOT OR WITH DRAINAGE AREAS LESS THAN 1 SQUARE MILE; AND AREAS PROTECTED BY LEVEES FROM 1% ANNUAL CHANCE FLOOD) ACCORDING TO THE FLOOD INSURANCE RATE MAP FOR THE COUNTY OF MARICOPA, COMMUNITY PANELS NO. 04013C2295L, EFFECTIVE DATE OCTOBER 16, 2013.

# PROJECT DESCRIPTION DRAINAGE STATEMENT

THIS IS AN EXISTING COMMERCIAL CENTER THAT WAS CONSTRUCTED IN EARLY 1909'S. ALL INFRASTRUCTURE INCLUSIVE OF PAVING, STORM DRAINAGE, SEWER, WATER AND RETENTION FACILITIES WERE CONSTRUCTED, APPROVED AND ACCEPTED. THIS PROJECT PROPOSES TO CONSTRUCT A 2,000+ S.F. ADDITION TO THE SOUTH OF THE EXISTING BUILDING, INCLUSIVE OF NEW PATIOS. THE NEW ADDITION WILL REPLACE AN EXISTING PAVED AREA SO THERE IS NO INCREMENTAL ADDITION OF IMPERVIOUS COVER. FURTHER MORE ALL EXISTING UTILITIES SHOWN HEREON, SHALL REMAIN IN PLACE. ALL EXISTING DRAINAGE PATTERNS SHALL BE MAINTAINED WITH OUTFALL BEING THE COMMON RETENTION BASIN ON THE WEST SIDE.

EXISTING UTILITY POLE

# KEY MAP

# INDEX OF PLAN SHEETS

COVER SHEET

PRELIMINARY GRADING, DRAINAGE AND UTILITY PLAN

PROPOSED STORM DRAIN MANHOLE

# **ARCHITECT**

VERTICAL DESIGN STUDIOS 4650 EAST COTTON CENTER BLVD., SUITE 200 PHOENIX, AZ 85040 PHONE: (602) 393-9353 CONTACT: TRISH FLOWER

# **OWNER/DEVELOPER**

EVERGREEN DEVELOPMENT 2390 E. CAMELBACK ROAD, SUITE 410 PHOENIX, ARIZONA 85016 PHONE: (602) 567-7116 FAX: (602) 567-7155 CONTACT: STEVE RUSSELL

### **ENGINEER:**

OPTIMUS CIVIL DESIGN GROUP 4650 EAST COTTON CENTER BLVD.. SUITE 200 PHOENIX, ARIZONA 85034 PHONE: (602) 286-9300 FAX: (602) 286-9400

# LEGAL DESCRIPTION

LOT 2, SUPERSTITION SPRINGS PARCEL G, ACCORDING TO BOOK 359 OF MAPS, PAGE 15, RECORDS OF MARICOPA COUNTY, ARIZONA.

# BASIS OF BEARINGS

N. 89°26'55" E. ALONG HAMPTON AVE. PER THE RECORDED PLAT OF "SUPERSTITION SPRING PARCEL G" IN BOOK 359 OF MAPS PAGE 15, M.C.R.

# **BENCHMARK**

A FOUND BRASS TAG ON TOP OF CURB AT THE NORTHEAST CORNER OF POWER ROAD AND US 60. ELEVATION: 1371.80 (CITY OF MESA DATUM)

SCALE IN FEET: 1"=40'

GROSS: 58,765 S.F. OR 1.35 AC.

SECTION ILA AND IZONA A PORTION TOWNSHIP 1 RIVEF






DESIGNED:	AJR
DRAWN:	JS
CHECKED:	JDB
DATE:	5/15/15
JOB NO.:	151208

DRAWING NO



					LEGEND				
	FOUND BRASS CAP IN HAND HOLE		EXISTING CATCH BASIN		EXISTING SHUT OFF SWITCH	P XX.XX	SPOT ELEVATION		PROPOSED RIPRAP
•	FOUND BRASS CAP FLUSH		EXISTING STORM DRAIN MANHOLE EXISTING SIGN	E	EXISTING PULL/JUNCTION BOX EXISTING ELECTRIC UTILITY	C CO GR	CONCRETE ELEVATION CURB OPENING ELEVATION GRATE ELEVATION		PROPOSED FLOW LINE
	FOUND MONUMENT AS SHOWN	CO	EXISTING SANITARY SEWER MANHOLE EXISTING SEWER CLEANOUT	© -\$\dots	EXISTING TELEPHONE MANHOLE EXISTING LIGHT POLE	P	PAVEMENT ELEVATION	<u> </u>	SLOPE OUT 4:1 MAXIMUM PROPOSED WALL
0	SET 1/2" REBAR WITH RLS 57382 CAP	₩>	EXISTING TRAFFIC SIGNAL	OHE	EXISTING OVERHEAD ELECTRIC		- PROPOSED WATER LINE		DRAINAGE AREA BOUNDARY
	SET NAIL WITH RLS 57382 TAG	<b>•</b> ∞	EXISTING FIRE HYDRANT EXISTING BACKFLOW PREVENTER	\[3		——S—	- PROPOSED SEWER LINE PROPOSED SEWER CLEANOUT		FLOW ARROW
	EASEMENT LINE PROPERTY LINE	⊗ G □	EXISTING WATER VALVE	<u>FO</u>	EXISTING FIBER OPTIC	$\overset{\circ}{\infty}$	PROPOSED BACKFLOW PROPOSED WATER METER	(x)	DRAINAGE AREA DESIGNATOR
	BOUNDARY LINE		EXISTING GAS VENT	<u>-</u>	EXISTING TELEPHONE LINE		PROPOSED CATCH BASIN		

EXISTING SPOT ELEVATION

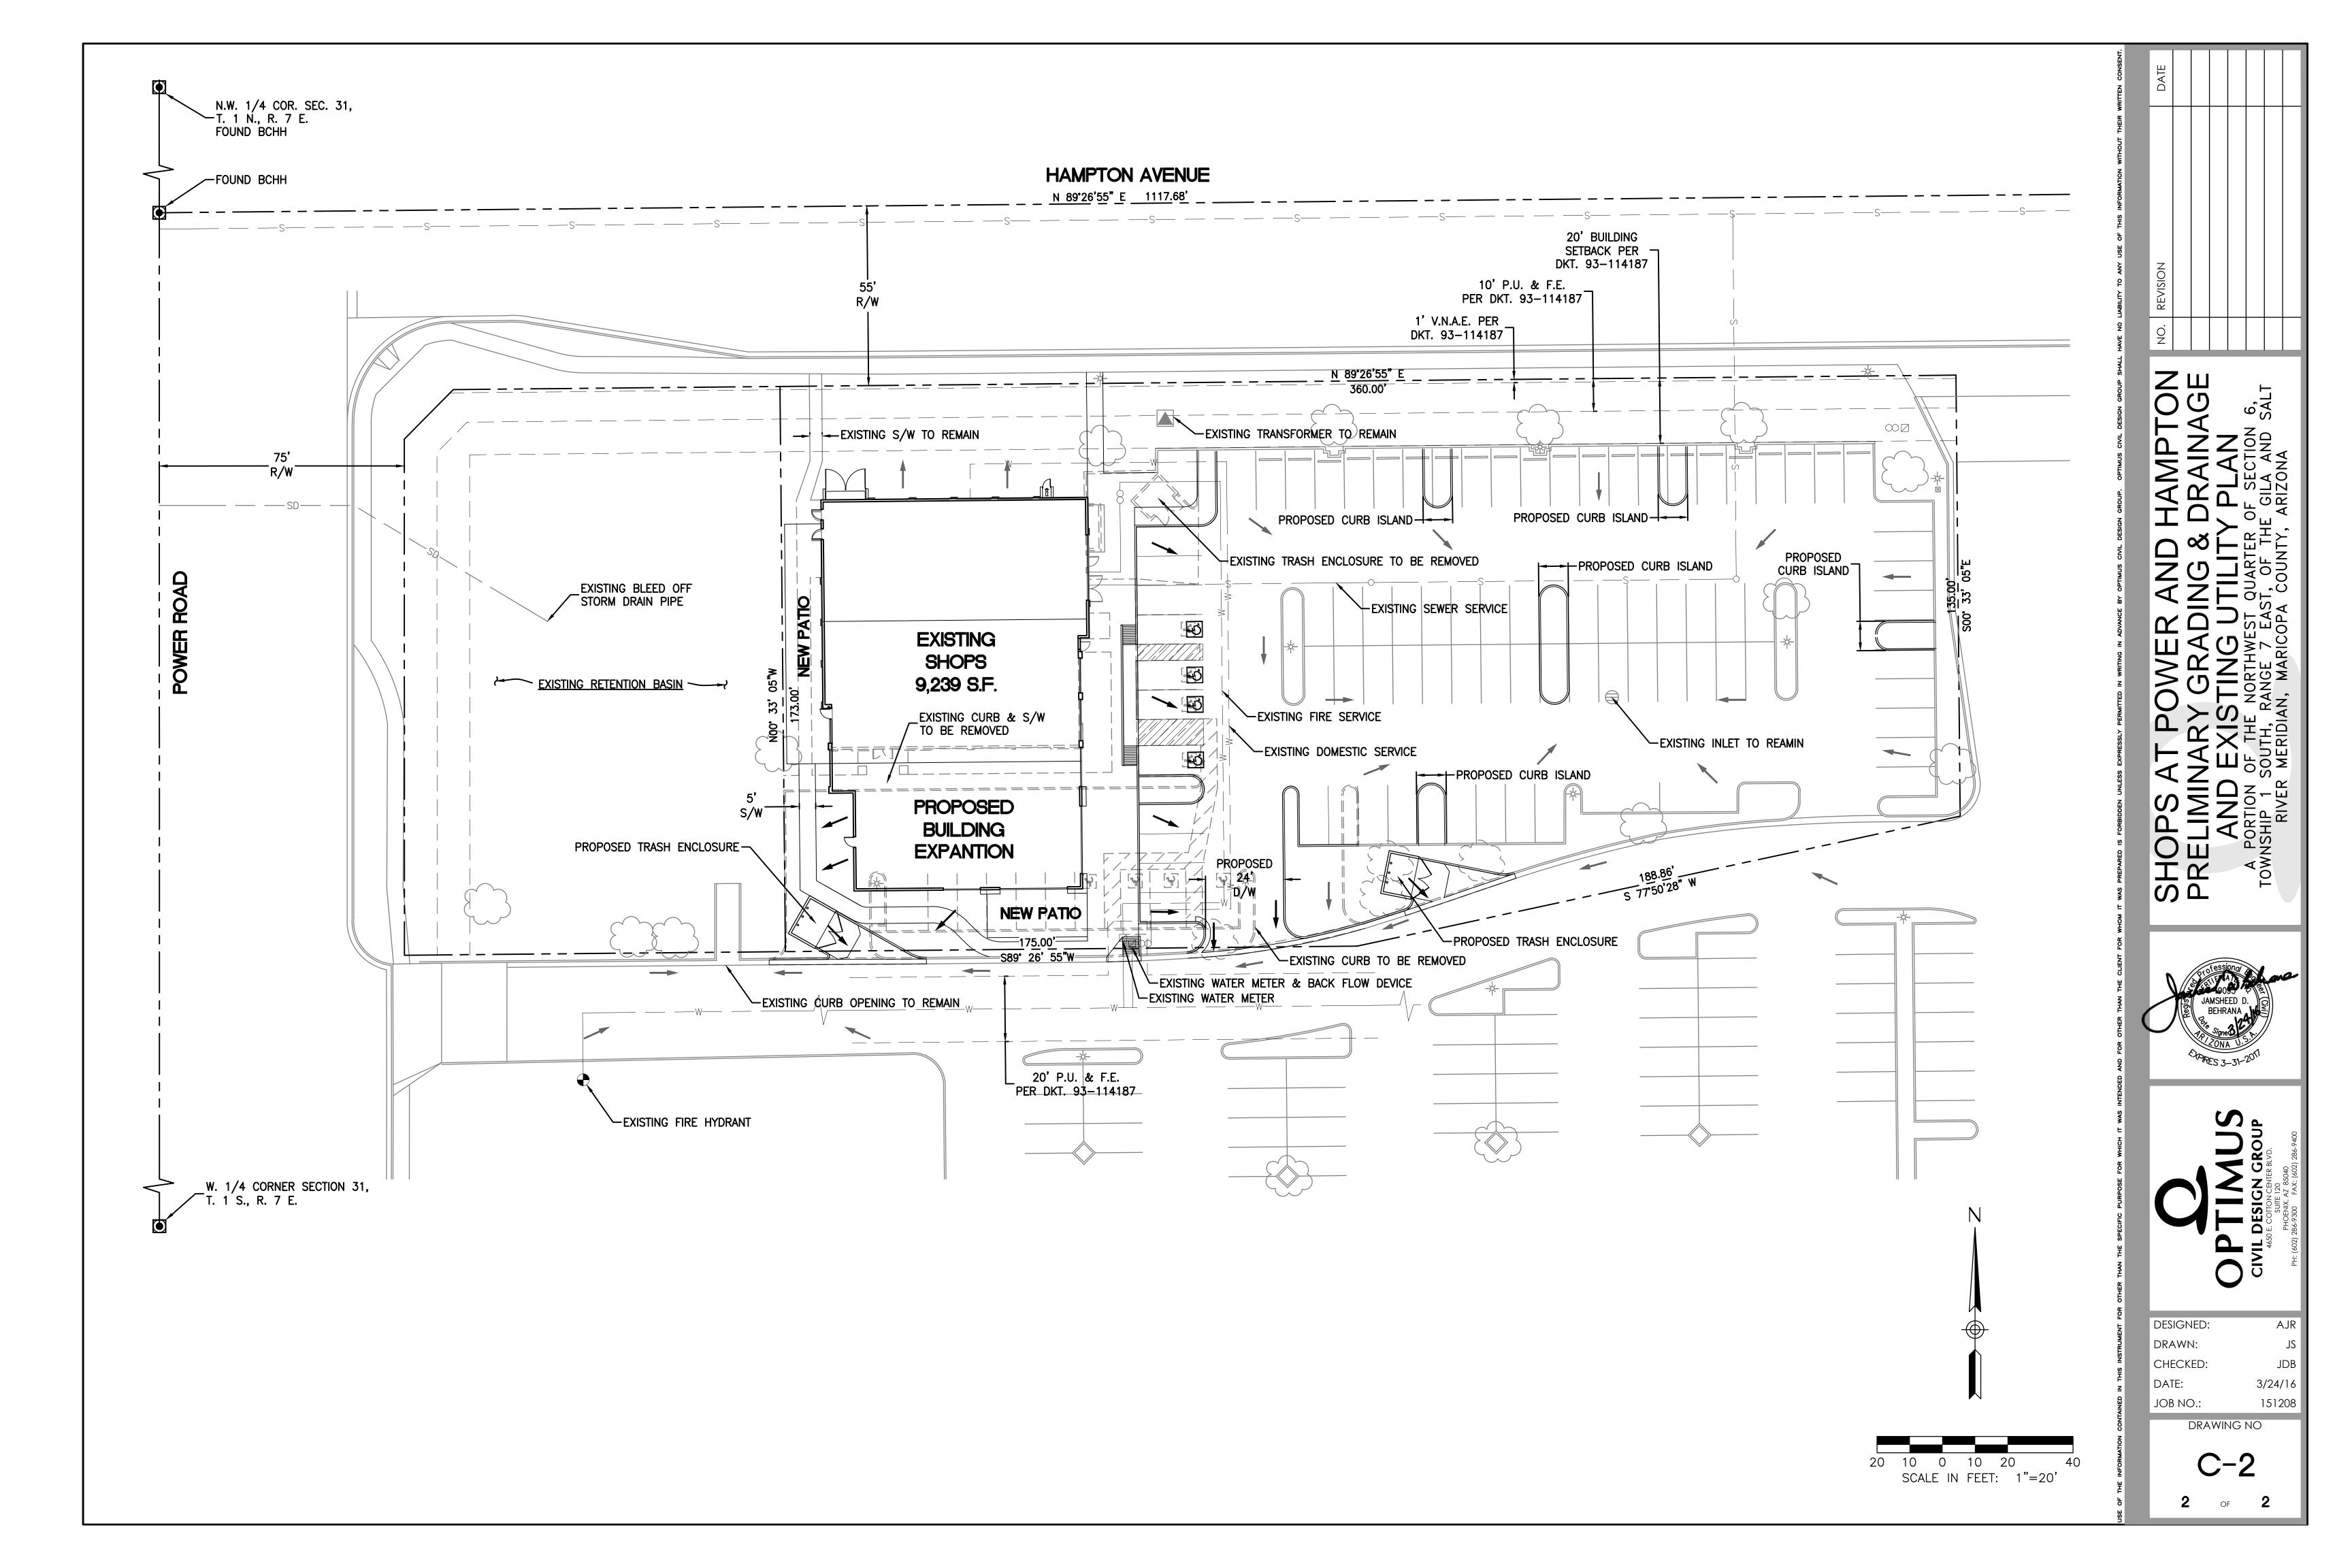

# (landscape & irrigation plan)

# project consultants

#### developer

EVERGREEN DEVELOPMENT 2390 EAST CAMELBACK ROAD #410 PHOENIX, ARIZONA 85016 PROJECT CONTACT: STEVE RUSSELL PHONE: 602.808.8600

VERTICAL DESIGN STUDIOS 4650 EAST COTTON CENTER BLVD. #130 PHOENIX, ARIZONA 85040 PROJECT CONTACT: TRISH FLOWERS PHONE: 602.395.1000 EMAIL:tflowers@verticaldesignstudios.com

# landscape architecture:

DESIGN ETHIC, LLC 8526 EAST MITCHELL DRIVE SCOTTSDALE, ARIZONA 85251 PROJECT CONTACT: BRANDON PAUL PHONE: 480.225.7077

# site data:

GROSS SITE AREA: ON-SITE LANDSCAPE AREA:

58,765 SF (1.39 ACRES) 15,338 S.F. (27 %)


# city of mesa notes

ALL LANDSCAPING WITHIN THE RIGHT-OF-WAY IS IN CONFORMANCE WITH THE LOW WATER USE PLANT LIST PROVIDED BY THE ARIZONA DEPT. OF WATER RESOURCES.

ALL LANDSCAPING INSTALLED WITH THIS PROJECT SHALL BE MAINTAINED BY MANAGEMENT COMPANY.

ALL TREES AND SHRUBS LOCATED IN THE LINE-OF-SIGHT WILL BE MAINTAINED FOR A CLEAR AREA BETWEEN 3' TO 7'

ALL BACKFLOW PREVENTERS 2" OR LARGER SHALL BE SCREENED WITH LANDSCAPE MATERIAL LOCATED WITHIN A 6' RADIUS OF OF THE BACKFLOW PREVENTER. ALL BACKFLOW PREVENTERS LESS THAN 2" SHALL BE PLACED IN A WIRE MESH BASKET AND PAINTED TO MATCH THE PRIMARY BUILDING COLOR.

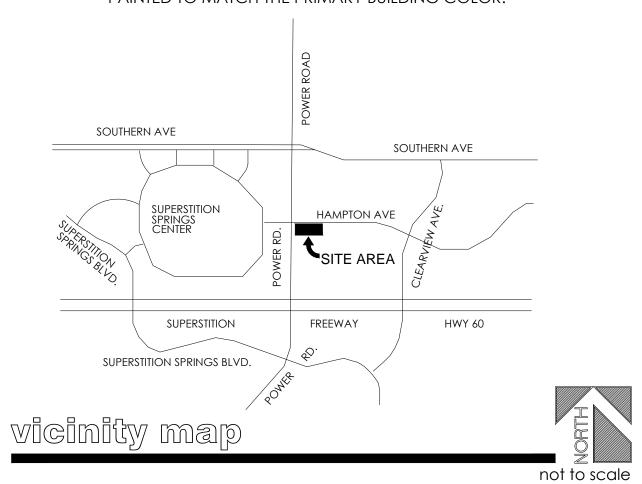


CALL TWO WORKING DAYS BEFORE YOU DIG 602-263-1100 1-800-STAKE-IT (OUTSIDE MARICOPA COUNTY)

# existing landscape & irrigation notes

- 1. SITE VERIFY ALL EXISTING CONDITIONS PRIOR TO BIDDING. ANY DISCREPANCIES ARE TO BE BROUGHT TO THE LANDSCAPE ARCHITECT'S ATTENTION WITHIN 24 HOURS OF THE OBSERVATION.
- 2. CONTRACTOR TO INSPECT EXISTING IRRIGATION SYSTEM AND VERIFY THAT THE SYSTEM IS WORKING PROPERLY.
- 3. ALL PLANT MATERIAL DESIGNATED AS "EXISTING TO REMAIN" SHALL BE PROTECTED DURING ALL PHASES OF CONSTRUCTION. ANY TREE(S) THAT DIE DUE TO: LACK OF WATER, LACK OF MAINTENANCE OR CARE, NEGLECT OR VANDALISM SHALL BE REPLACED BY A SIMILAR SPECIES OF TREE, (MINIMUM 48" BOX) AT NO ADDITIONAL COST TO OWNER. PALMS THAT DIE SHALL BE BE REPLACED WITH LIKE TYPE: HEIGHT AND SIZE. ALL SHRUBS AND GROUNDCOVER SHALL BE REPLACED WITH 5 GALLON PLANTS.
- 4. LANDSCAPE AREAS DISTURBED BY NEW CONSTRUCTION SHALL BE REPAIRED WITH NEW DECOMPOSED GRANITE MATCHING EXISTING. BLEND ALL DISTURBED AREAS WITH UNDISTURBED SO THERE IS A SMOOTH TRANSITION BETWEEN ALL EDGES. REPLACE ALL DISTURBED, BROKEN OR DAMAGED HEADERS WITH MATCHING TYPE.
- 5. ALL EXISTING PLANT MATERIAL AND ADJACENT PLANT MATERIAL SHALL HAVE UN-INTERRUPTED WATERING DURING ALL PHASES OF CONSTRUCTION. THIS SHALL INCLUDE BUT NOT BE LIMITED TO; HAND WATERING, TEMPORARY ABOVE GROUND IRRIGATION, EXISTING SYSTEM, ETC.
- 6. THE EXISTING IRRIGATION SYSTEM SHALL BE PROTECTED, MAINTAINED AND REPAIRED DURING ALL PHASES OF CONSTRUCTION. ALL EQUIPMENT SUCH AS MAINLINE, WIRES, LATERAL HEADS AND ETC. SHALL BE REPAIRED AND REPLACED TO MAINTAIN CONTINUOUS WATER.
- 7. PROVIDE NEW SCHEDULE 40 SLEEVES AT ALL NEW DRIVES. (SEE SLEEVE SCHEDULE FOR SIZE.) ANY EXISTING IRRIGATION SYSTEM IS TO BE MAINTAINED AT ALL TIMES DURING CONSTRUCTION AND GUARANTEE 100% COVERAGE.
- 8. EXISTING TREES TO REMAIN SHALL BE SELECTIVELY PRUNED.
- 9. ALL EXISTING SHRUBS WITHIN THE SIGHT DISTANCE LINES AND SIGHT VISIBILITY TRIANGLES SHALL BE SELECTIVELY PRUNED SO THAT THEY DO NOT EXCEED A MAXIMUM HEIGHT OF 30 INCHES.
- 10. ALL EXISTING TREES SHALL BE TRIMMED TO MAINTAIN A CLEAR A MINIMUM CANOPY HEIGHT OF 7 FEET.

# mlamf leaend

	botanical name common name	emitters	size	qty	comments
existing trees					
(#)	SPECIES VARY SEE LEGEND		existing	14	REMAIN IN PLAC
existing shruk	OS				
	DASYLIRION WHEELERI DESERT SPOON		existing	44	REMAIN IN PLAC
	LEUCOPHYLLUM FRUTESCENS 'GREEN CLOUD' GREEN CLOUD SAGE		existing	21	REMAIN IN PLAC
$\bigoplus$	CAESALPINIA PULCHERRIMA RED BIRD OF PARADISE		EXISTING	13	REMAIN IN PLAC
€	SENNA ARTEMISIOIDES FEATHERY CASSIA		existing	19	REMAIN IN PLAC
(i)	NERIUM OLEANDER PETITE PINK OLEANDER		existing	8	REMAIN IN PLAC
€ trees	LANTANA MONTEVIDENSIS PURPLE LANTANA		EXISTING	5	REMAIN IN PLAC
	ACACIA SALICINA WILLOW ACACIA	(5 @ 1.0 GPH)	1" CAL. /24" BOX	2	H., W., CAL. STAKE IN PLACE
	PARKINSONIA X. 'DESERT MUSEUM' 'DESERT MUSEUM'	(6 @ 1.0 GPH)	1" CAL. /24" BOX	15	H., W., CAL. STAKE IN PLACE
	CAESALPINIA CACALACO 'SMOOTHIE' THORNLESS CASCALOTE	(5 @ 1.0 GPH)	1" CAL. /24" BOX	6	H., W., CAL. STAKE IN PLACE
	PROSOPIS SEEDLESS HYBRID 'AZT™' 'AZT™' SEEDLESS HYBRID MESQUITE	(5 @ 1.0 GPH)	1" CAL. /24" BOX	2	H., W., CAL. STAKE IN PLACE
shrubs	LEUCOPHYLLUM FRUTESCENS 'GREEN CLOUD'		5 GAL.	12	PLANT AT 4' O.C.
( <u>6</u> )	GREEN CLOUD SAGE  NERIUM OLEANDER PETITE PINK OLEANDER		5 GAL.	11	PLANT AT 4' O.C.
•	RUELLIA BRITTONIANA MEXICAN PETUNIA		5 GAL.	68	PLANT AT 4' O.C.
₩	SENNA ARTEMISIOIDES FEATHERY CASSIA		5 GAL.	7	PLANT AT 4' O.C
accents	TECOMA ALATA ORANGE JUBILEE		5 GAL.	13	PLANT AT 4' O.C.
groundcove	DASYLIRION WHEELERI DESERT SPOON r		5 GAL.	26	PLANT AT 4' O.C.
(±	LANTANA MONTEVIDENSIS PURPLE LANTANA		1 GAL.	46	PLANT AT 4' 0.C.
<u>inerts</u>			1 GAL.	43	PLANT AT 2' O.C.
	DECOMPOSED GRANITE MATCH EXISTING			15,338 SF	2" MINIMUM IN ALL PLANTERS

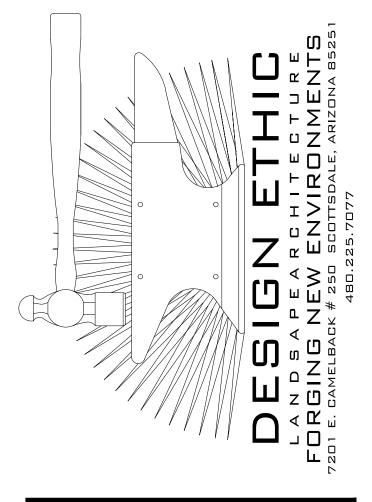




# ER REL $\infty$

JOB NO: 16-017 DATE: DRAWN BY: B. PAUL SUBMITTED: 03.23.2016

**REVISED:** 

PL.01 of PL.02


SHEET

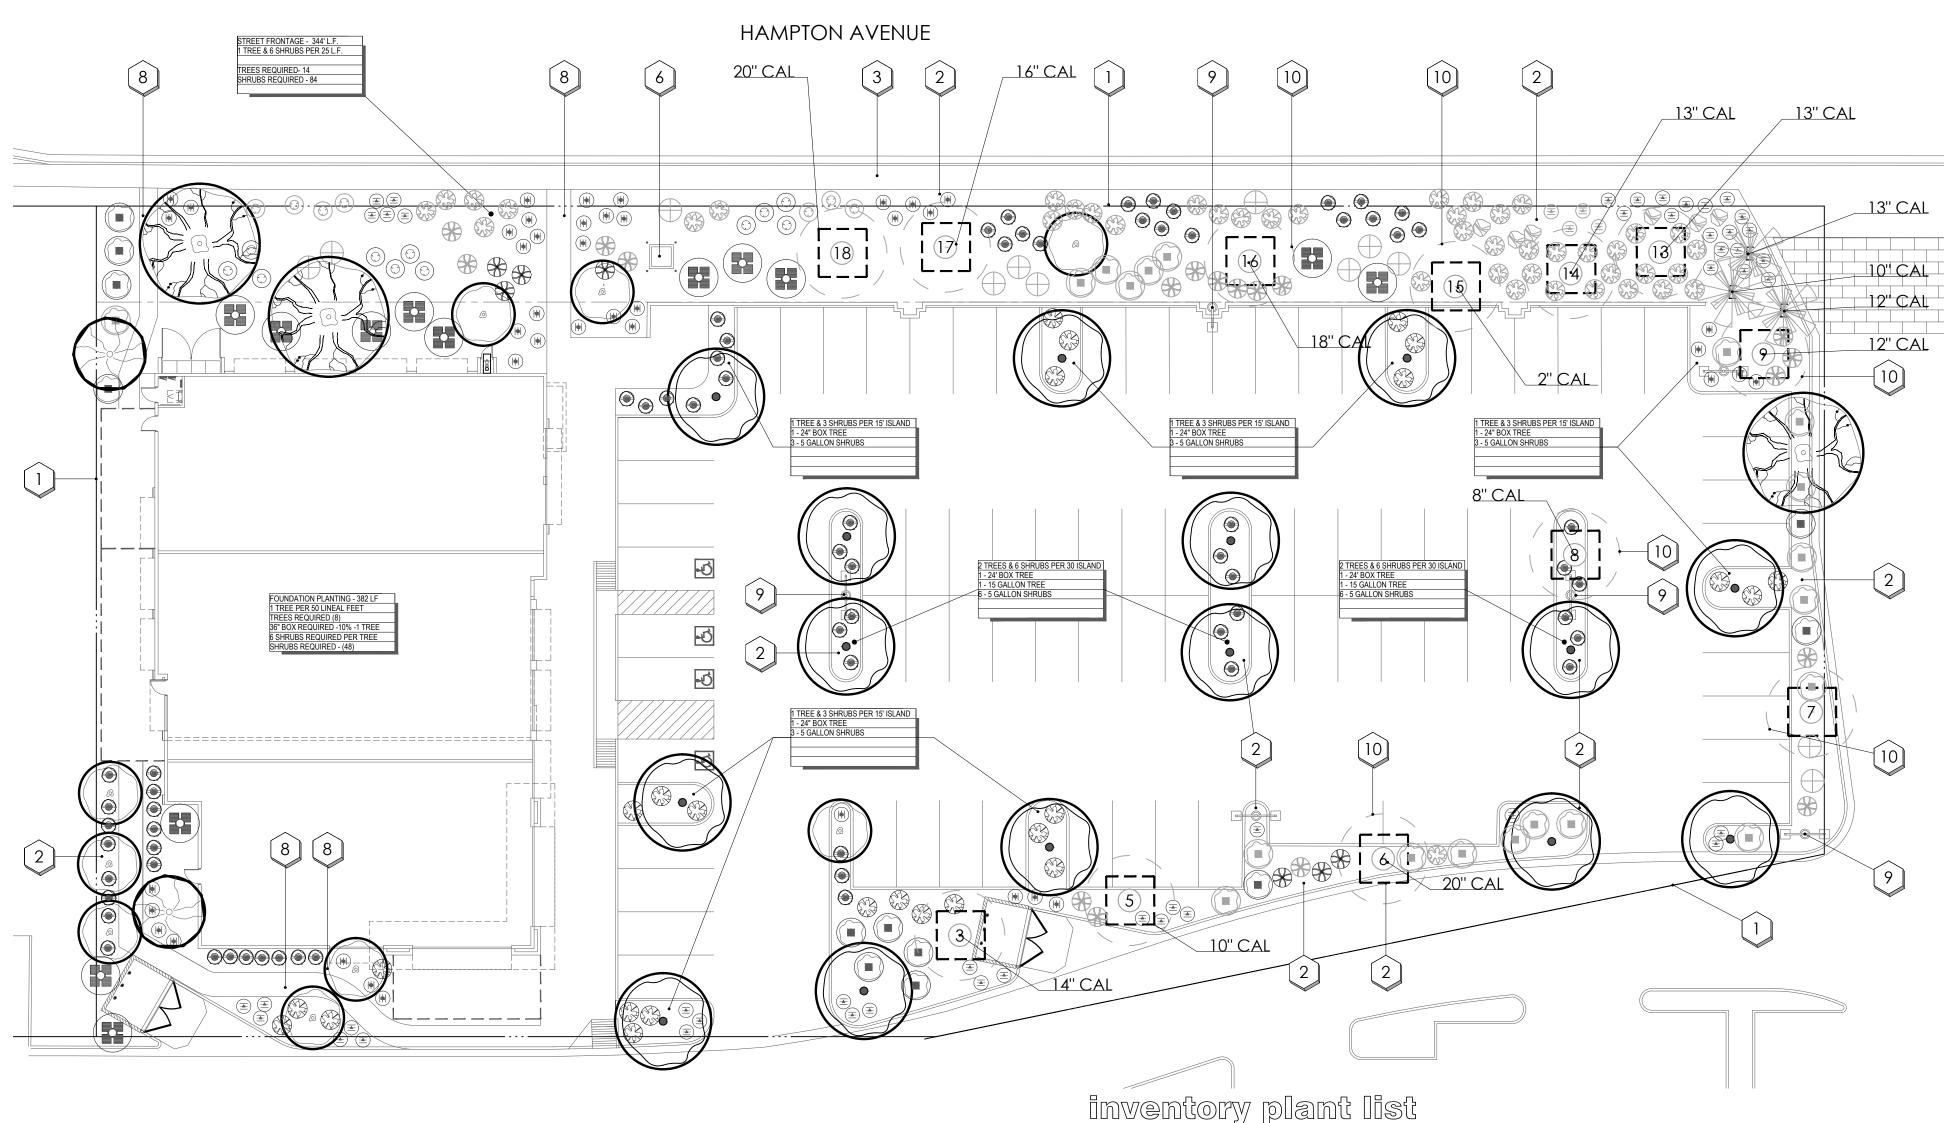

P= PROTEC NS = NON -S= SALVAGEABLE D= DESTROY

H=HEALTHY NH= NOT HEALTHY

DI=DIEING

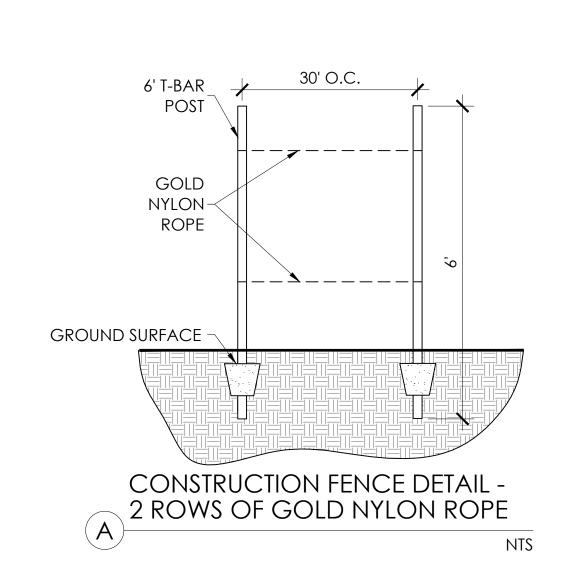



	imve	entory	plant
CT IN PLACE I - SALVGEABLE	Plant #	Inventory	Intended


Plant #	Inventory Designation	Intended Designation	Species	Scientific Name	Caliper (In)	Height (Ft)	Width (Ft)	Plant Condition
1	NS	D	Palo Brea	Parkinsonia Praecox	4	6	6	NH
2	S	Р	Palo Brea	Parkinsonia Praecox	13	28	20	Н
3	S	Р	Palo Brea	Parkinsonia Praecox	14	30	30	Н
4	NS	D	Palo Brea	Parkinsonia Praecox	11	25	25	н
5	S	P	Thornless Chilean Mesquite	Prosopis Chilensis	10	20	20	Н
6	S	Р	Foothills Palo Verde	Parkinsonia microphylla	20	25	30	Н
7	S	Р	Thornless Chilean Mesquite	Prosopis Chilensis	9	18	18	Н
8	S	Р	Thornless Chilean Mesquite	Prosopis Chilensis	8	16	16	Н
9	S	Р	Thornless Chilean Mesquite	Prosopis Chilensis	12	26	26	Н
10	S	Р	Mexican Fan Palm	Washingtonia Robusta	10	30	8	Н
11	S	Р	Mexican Fan Palm	Washingtonia Robusta	12	30	8	Н
12	S	Р	Mexican Fan Palm	Washingtonia Robusta	13	30	8	Н
13	S	Р	Palo Brea	Parkinsonia Praecox	14	35	30	NH
14	S	Р	Palo Brea	Parkinsonia Praecox	14	30	30	NH
15	S	Р	Guajillo	Acacia Berlandieri	2	10	10	Н
16	S	Р	Palo Brea	Parkinsonia Praecox	18	35	35	Н
17	S	Р	Thornless Chilean Mesquite	Prosopis Chilensis	16	25	25	NH
18	S	Р	Palo Brea	Parkinsonia Praecox	20	25	25	NH
19	NS	D	Willow Acacia	Acacia Salicina	18	40	20	Н
20	NS	D	Willow Acacia	Acacia Salicina	10	28	12	Н
21	NS	D	Willow Acacia	Acacia Salicina	8	15	12	Н
22	NS	D	Willow Acacia	Acacia Salicina	20	40	15	Н


# mlamf legend

existing trees				qty	comments
				• '	
(#)	SPECIES VARY SEE LEGEND		EXISTING	12	REMAIN IN PLAC
existing shruk	DS .				
	DASYLIRION WHEELERI DESERT SPOON		EXISTING	44	REMAIN IN PLAC
	LEUCOPHYLLUM FRUTESCENS 'GREEN CLOUD' GREEN CLOUD SAGE		existing	21	REMAIN IN PLAC
	CAESALPINIA PULCHERRIMA RED BIRD OF PARADISE		EXISTING	13	REMAIN IN PLAC
8	SENNA ARTEMISIOIDES FEATHERY CASSIA		EXISTING	19	REMAIN IN PLAC
0	NERIUM OLEANDER PETITE PINK OLEANDER		existing	8	REMAIN IN PLAC
	LANTANA MONTEVIDENSIS PURPLE LANTANA		EXISTING	5	REMAIN IN PLAC
	ACACIA SALICINA WILLOW ACACIA	(5 @ 1.0 GPH)	1" CAL. /24" BOX	2	H., W., CAL. STAKE IN PLACE
	PARKINSONIA X. 'DESERT MUSEUM' 'DESERT MUSEUM'	(6 @ 1.0 GPH)	1" CAL. /24" BOX	15	H., W., CAL. STAKE IN PLACE
	CAESALPINIA CACALACO 'SMOOTHIE' THORNLESS CASCALOTE	(5 @ 1.0 GPH)	1" CAL. /24" BOX	9	H., W., CAL. STAKE IN PLACE
	PROSOPIS SEEDLESS HYBRID 'AZTTM' 'AZTTM' SEEDLESS HYBRID MESQUITE	(5 @ 1.0 GPH)	1" CAL. /24" BOX	2	H., W., CAL. STAKE IN PLACE
shrubs	LEUCOPHYLLUM FRUTESCENS 'GREEN CLOUD' GREEN CLOUD SAGE		5 GAL.	12	PLANT AT 4' O.C
0	NERIUM OLEANDER PETITE PINK OLEANDER		5 GAL.	11	PLANT AT 4' O.C
	RUELLIA BRITTONIANA MEXICAN PETUNIA		5 GAL.	68	PLANT AT 4' O.C
€	SENNA ARTEMISIOIDES FEATHERY CASSIA		5 GAL.	7	PLANT AT 4' O.C
accents	TECOMA ALATA ORANGE JUBILEE		5 GAL.	13	PLANT AT 4' O.C
groundcove	DASYLIRION WHEELERI DESERT SPOON r		5 GAL.	26	PLANT AT 4' O.C
<b>(</b>			1 GAL.	46	PLANT AT 4' 0.C.
inerts (M	PURPLE LANTANA  LANTANA 'NEW GOLD'		1 GAL.	43	PLANT AT 2' O.C
	DECOMPOSED GRANITE MATCH EXISTING			15,338 SF	2" MINIMUM IN ALL PLANTERS

# planting key notes

- [1] PROPERTY LINE / RIGHT OF WAY LINE
- 2 DECOMPOSED GRANITE IN ALL PLANTING AREAS
- (3) SIGHT DISTANCE LINE PER CITY REQUIREMENTS
- (4) EXISTING SIDEWALK
- [5] FIRE HYDRANT NO PLANT MATERIAL WITHIN 3'
- (6) EXISTING TRANSFORMER
- 7 ACCESSIBLE RAMP. SEE CIVIL ENG. PLANS.
- 8 PROPOSED 5'-0" SIDEWALK.
- 9 EXISTING POWER POLE.
- 10 EXISTING TREE TO REMAIN (TYPICAL)
- PROTECT IN PLACE FENCING (TYPICAL). SEE DETAIL 'A', THIS SHEET

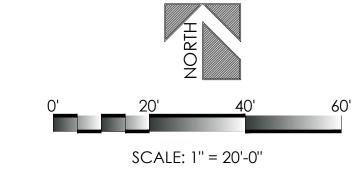

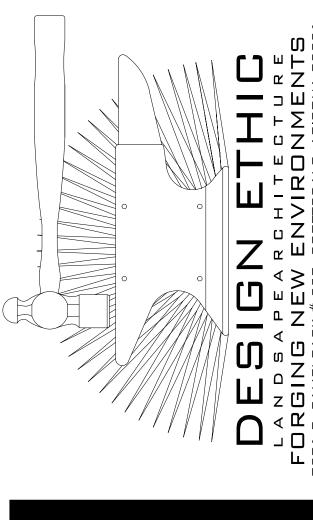



# $\infty$


JOB NO: 16-017 DATE: DRAWN BY:

REVISED:


B. PAUL 03.23.2016 SUBMITTED:


SHEET

PL.02 of PL.02

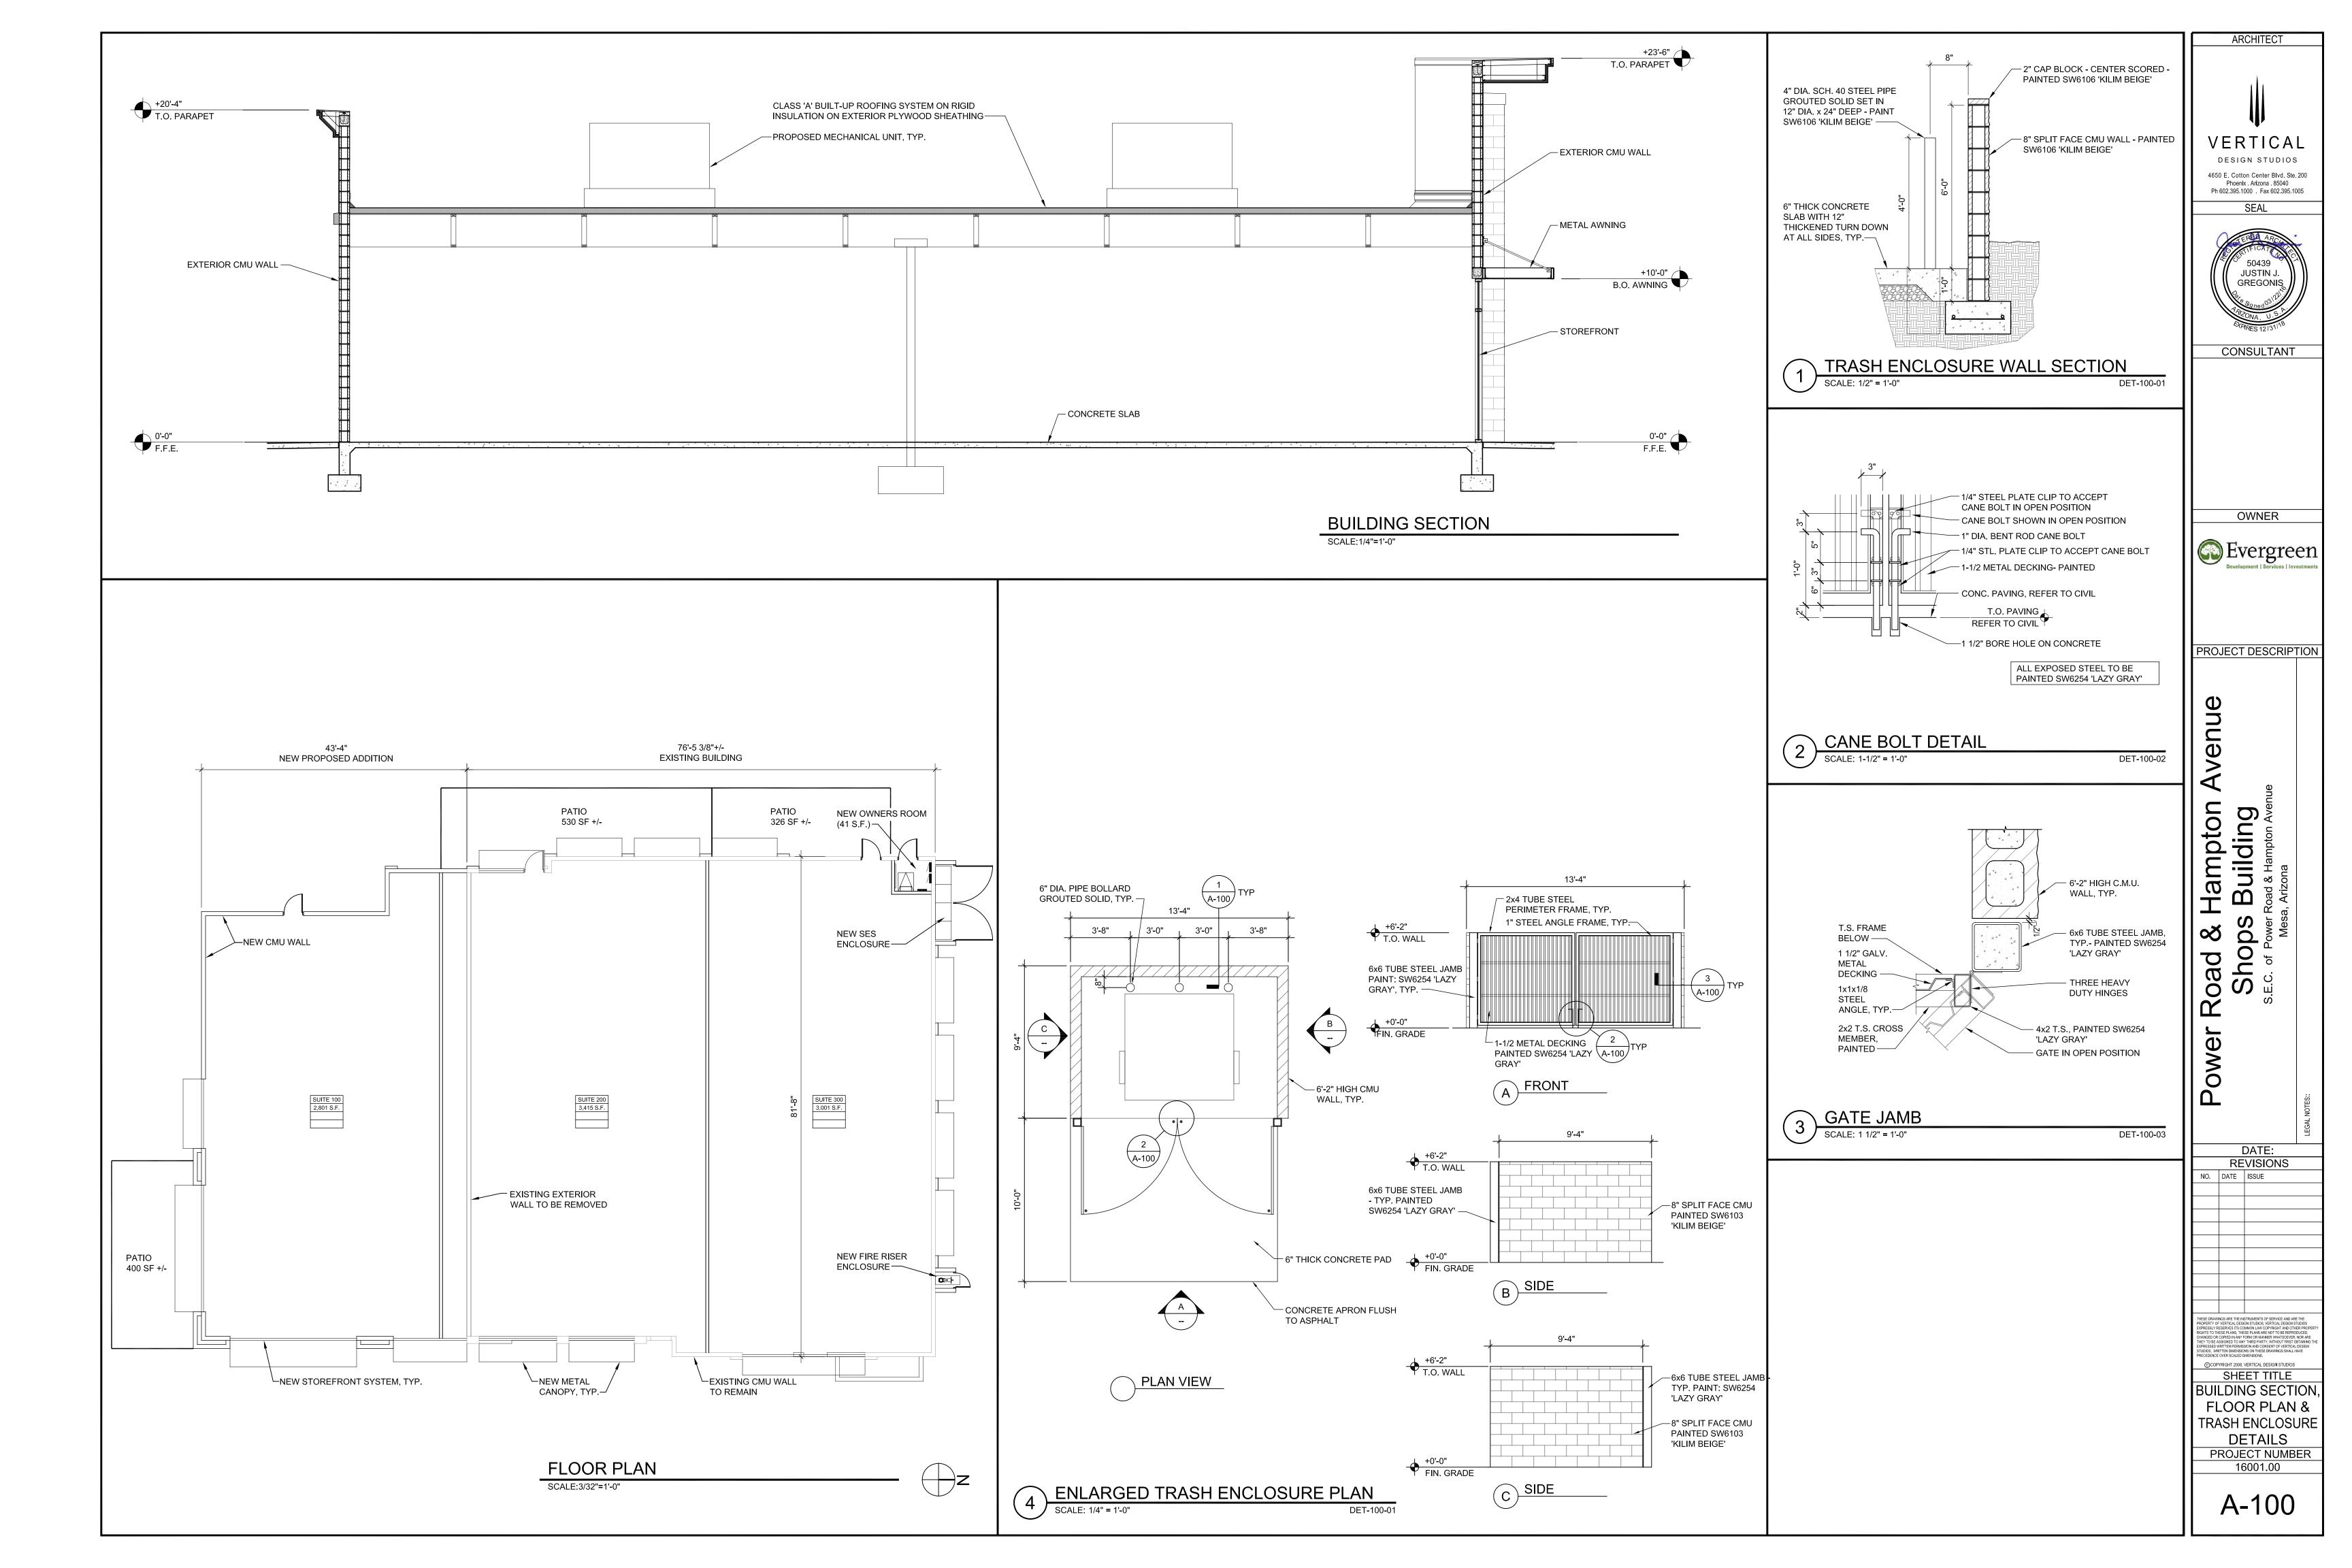



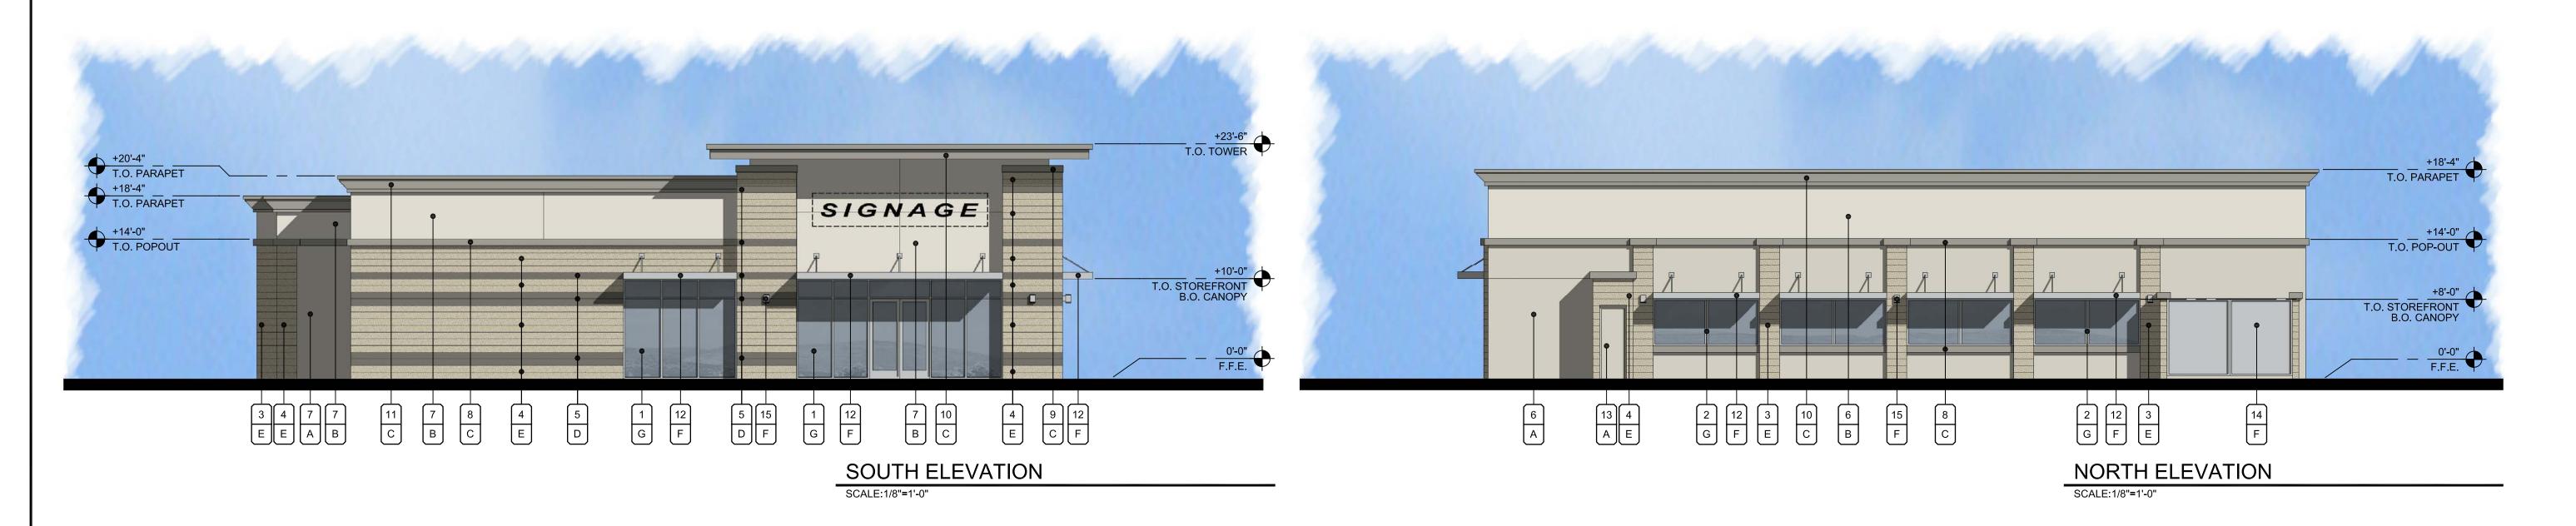

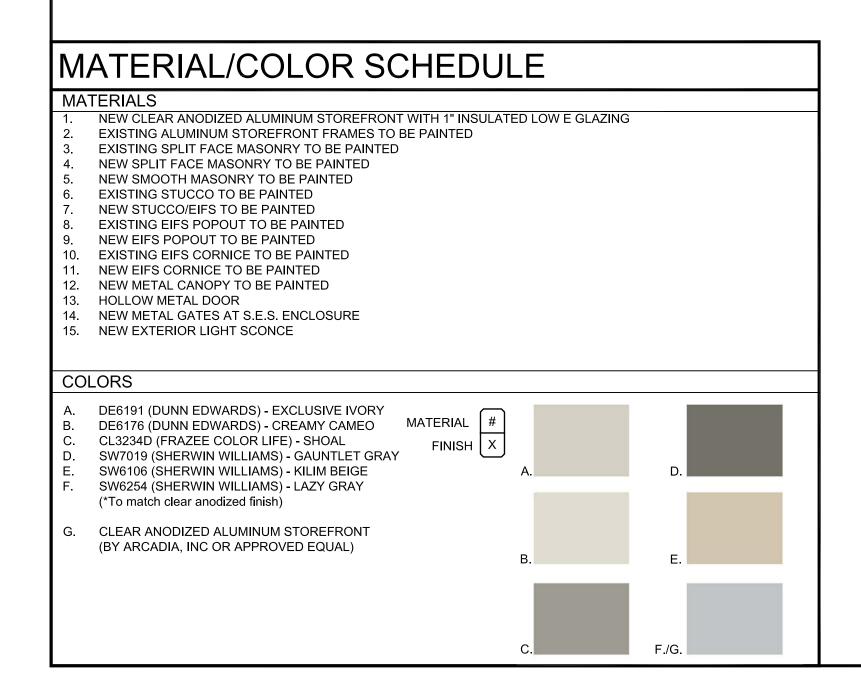




SCALE:1/8"=1'-0"

ARCHITECT VERTICAL DESIGN STUDIOS 4650 E. Cotton Center Blvd. Ste. 200 Phoenix . Arizona . 85040 Ph 602.395.1000 . Fax 602.395.1005 JUSTIN J. GREGONIŞ CONSULTANT OWNER Evergreen Evergreen Investments PROJECT DESCRIPTION venue Hampton S Building Road & F Shops Power DATE REVISIONS NO. DATE ISSUE SHEET TITLE **EXTERIOR ELEVATIONS &** COLOR / MATERIAL PALETTE

PROJECT NUMBER 16001.00

A-200

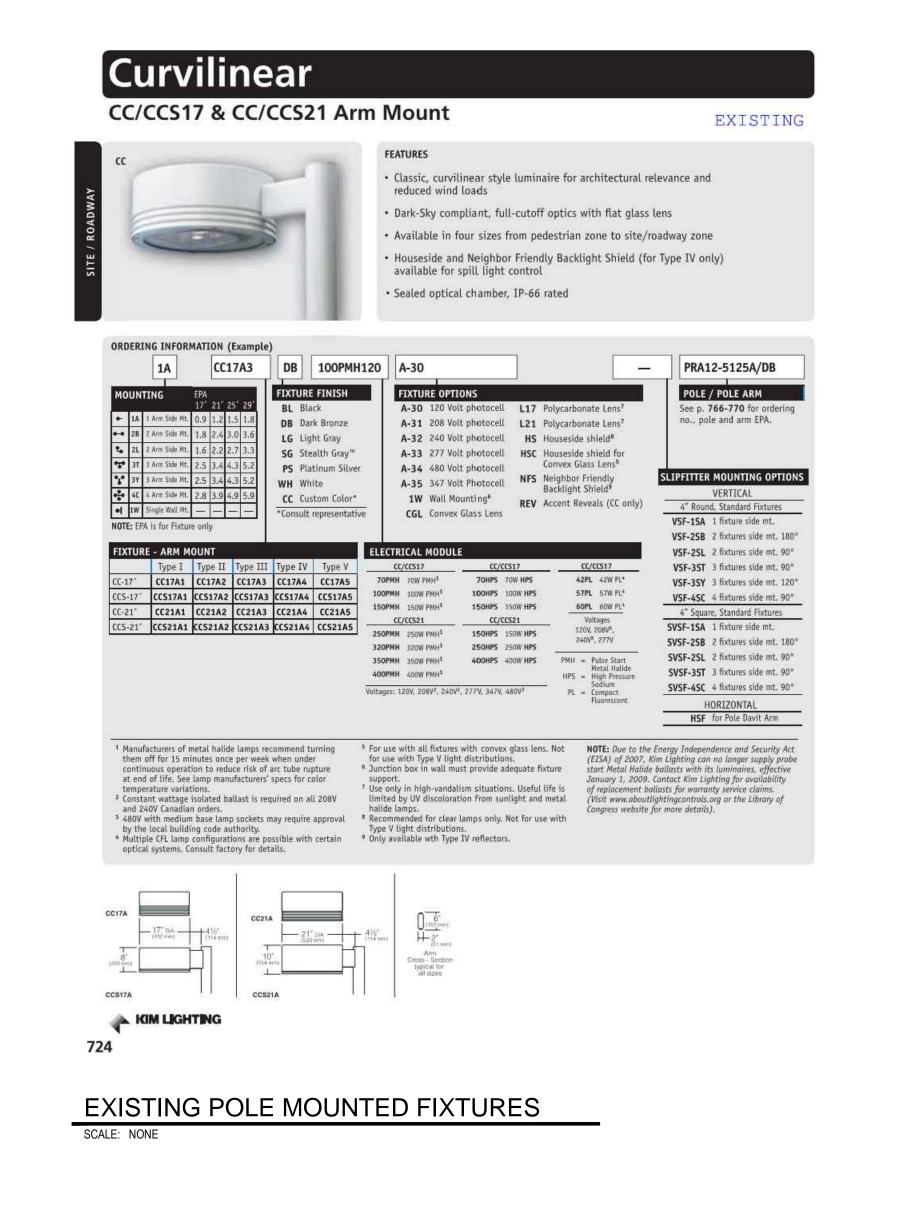



QUANTITY: \_\_\_\_\_\_ NOTE:


 $Ligman\ Lighting\ USA\ reserves\ the\ right\ to\ change\ specifications\ without\ prior\ notice,\ please\ contact\ factory\ for\ latest\ information.$ 

Due to the continual improvements in LED technology data and components may change without notice.

# FIXTURE TYPE 'A'

PROJECT:

SCALE: NONE

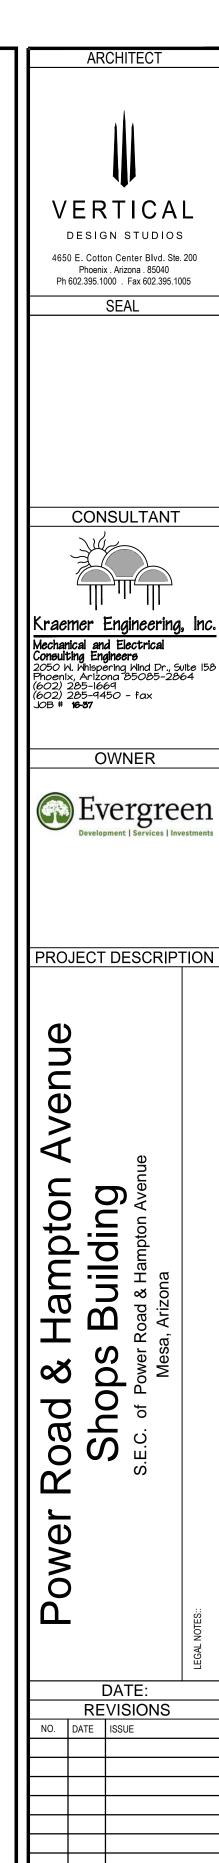

DATE REVISIONS

©COPYRIGHT 2008, VERTICAL DESIGN STUDIOS


SHEET TITLE

LIGHT FIXTURE

CUT SHEETS

PROJECT NUMBER 16001.00

E-200

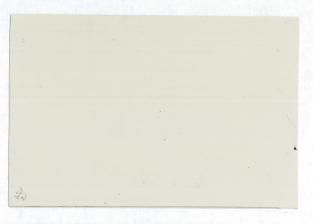

A. DE6191 'EXCLUSIVE IVORY' BY DUNN EDWARDS



D. SW7019 'GAUNTLET GRAY' BY SHERWIN WILLIAMS



B. DE6176 'CREAMY CAMEO' BY DUNN EDWARDS



E. SW6106 'KLIM BEIGE' BY SHERWIN WILLIAMS



C. CL3234D 'SHOAL' BY FRAZEE COLOR LIFE



F. SW6254 'LAZY GRAY' BY SHERWIN WILLIAMS (MATCH TO CLEAR ANODIZED METAL)



S.E.C. Power Rd. & Hampton Ave. Mesa, Arizona

